




**CONSTRUCTION OF MOTORIZED SHALLOW WELL -
GARMADOW SETTLEMENT -LUUQ DISTRICT- JUBALAND STATE**

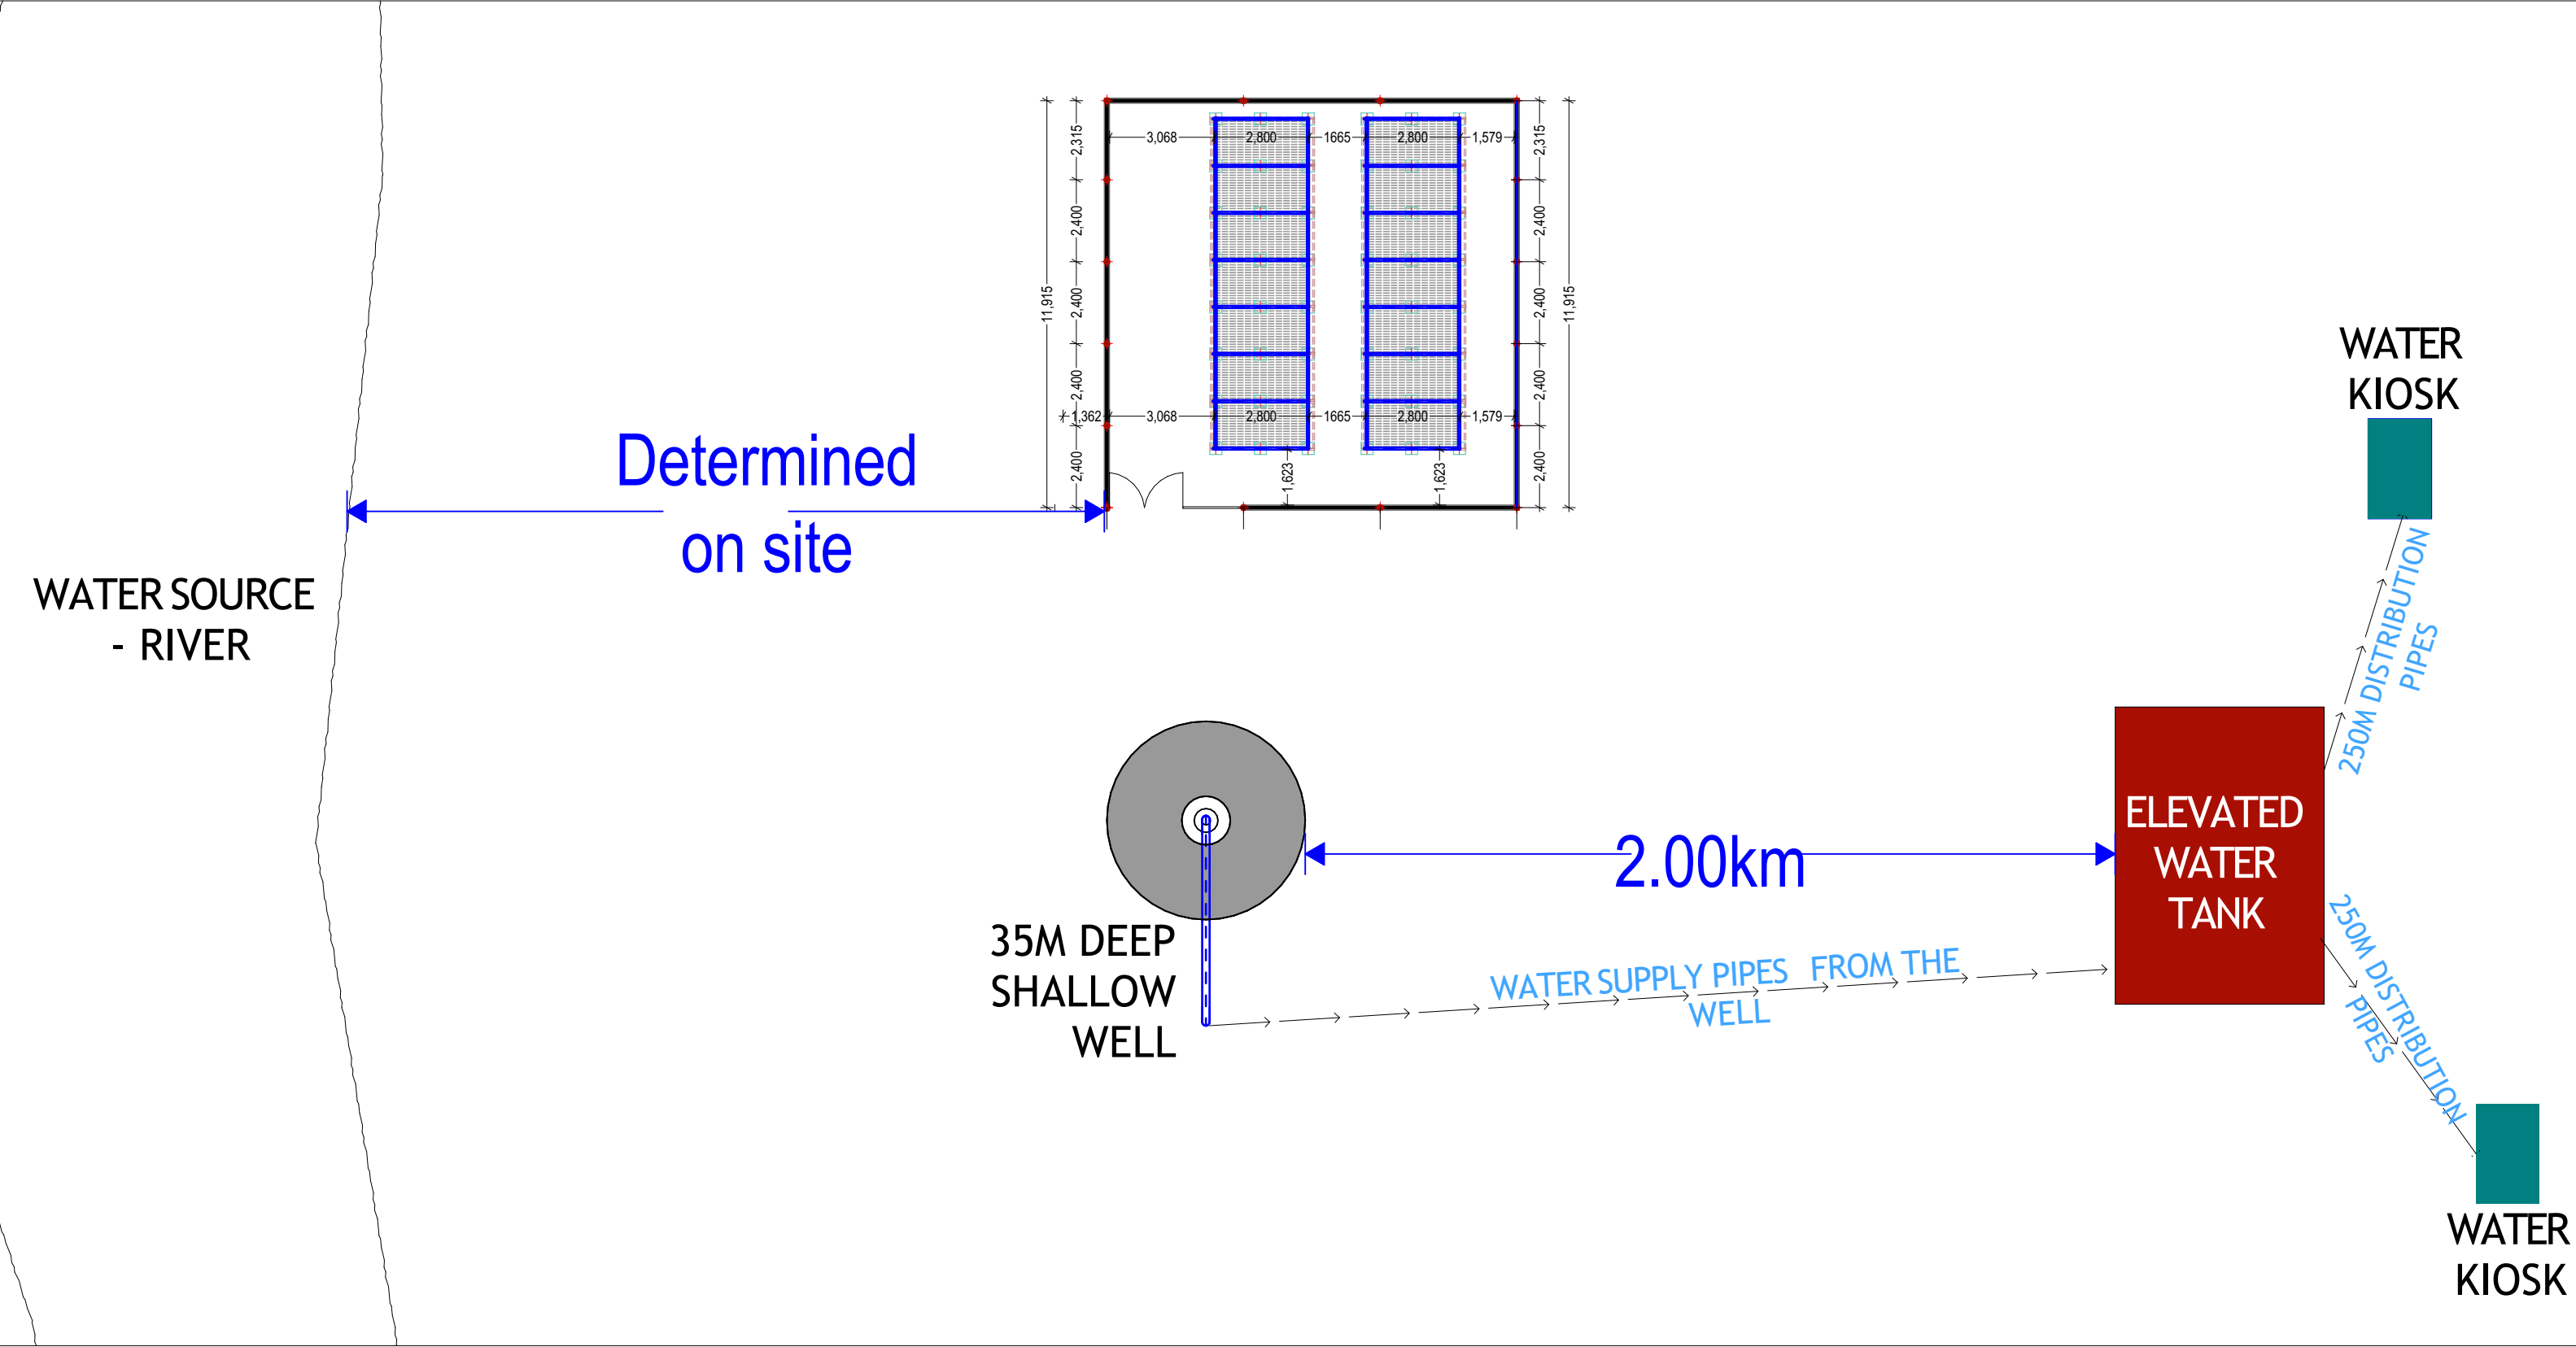


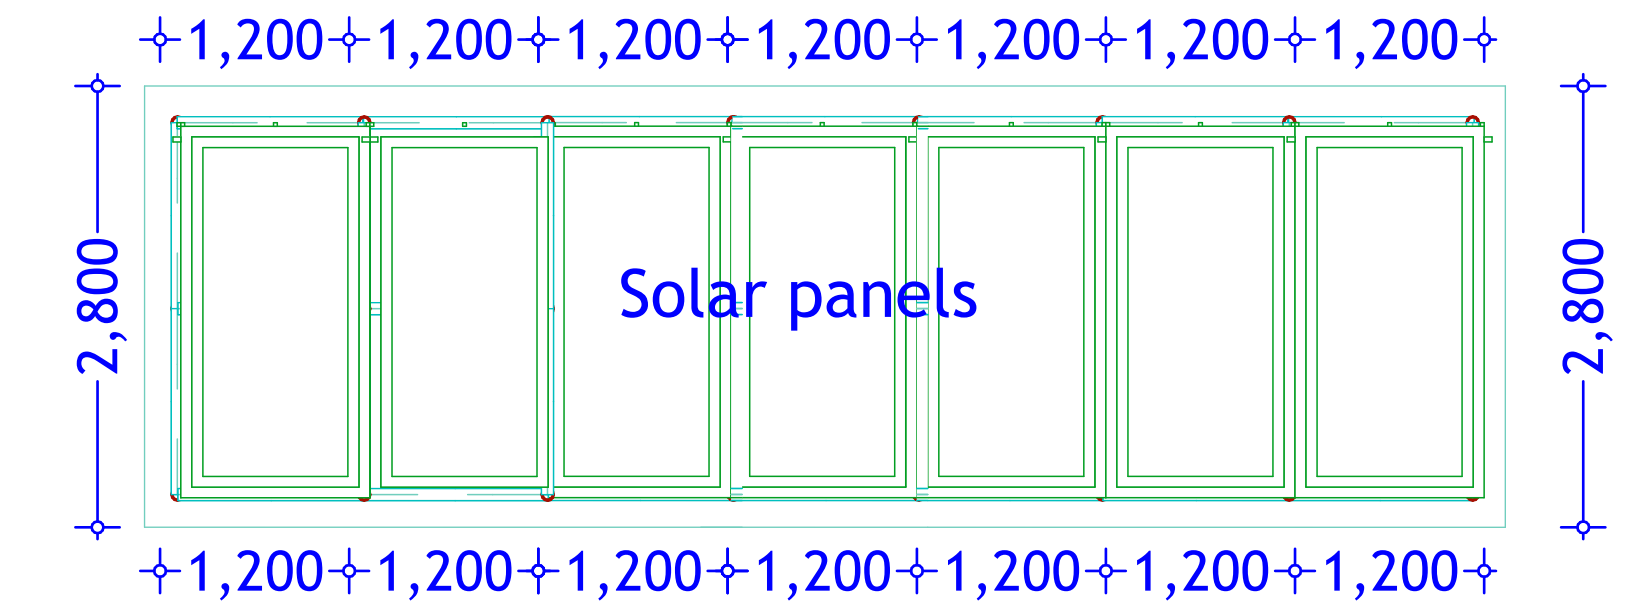


TYPICAL 7 NO. PANEL LAYOUT

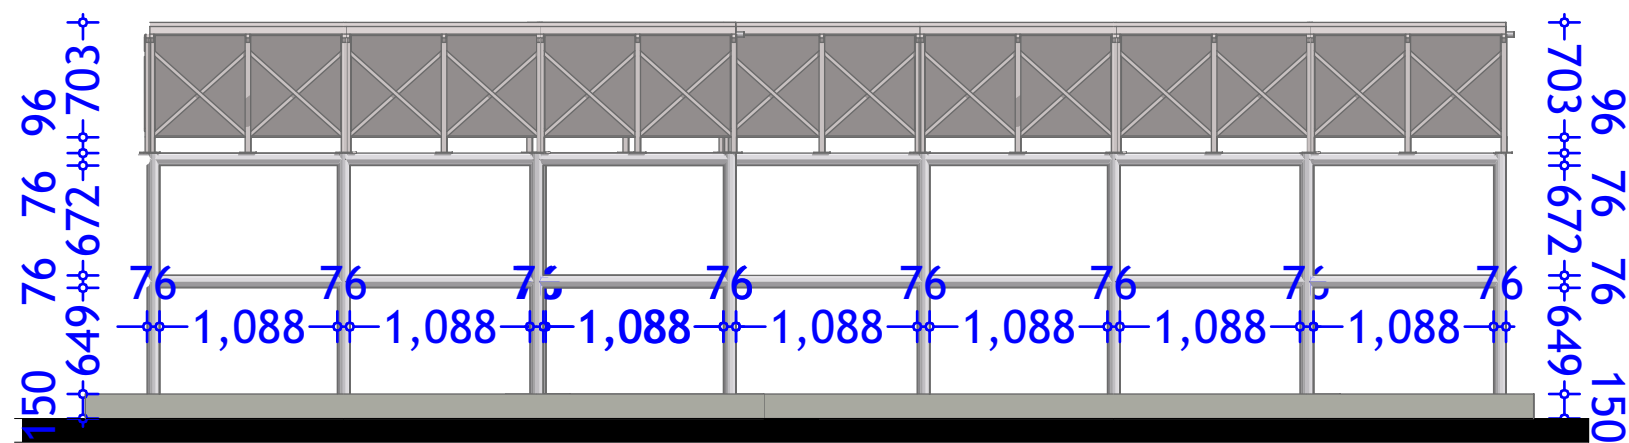


SOLAR STRUCTURE ELEVATION

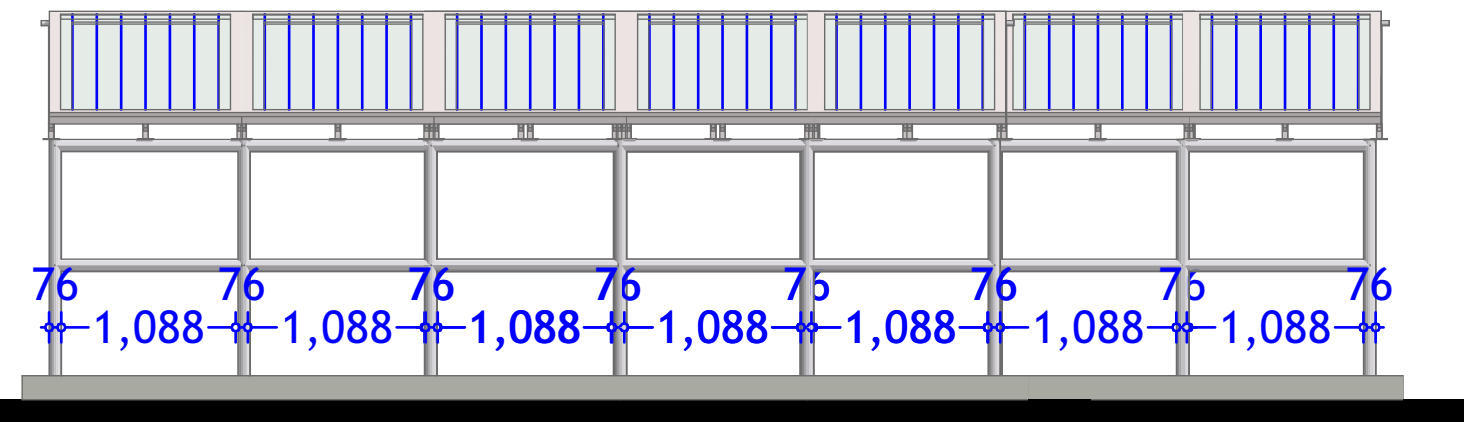


SOLAR STRUCTURE ELEVATION

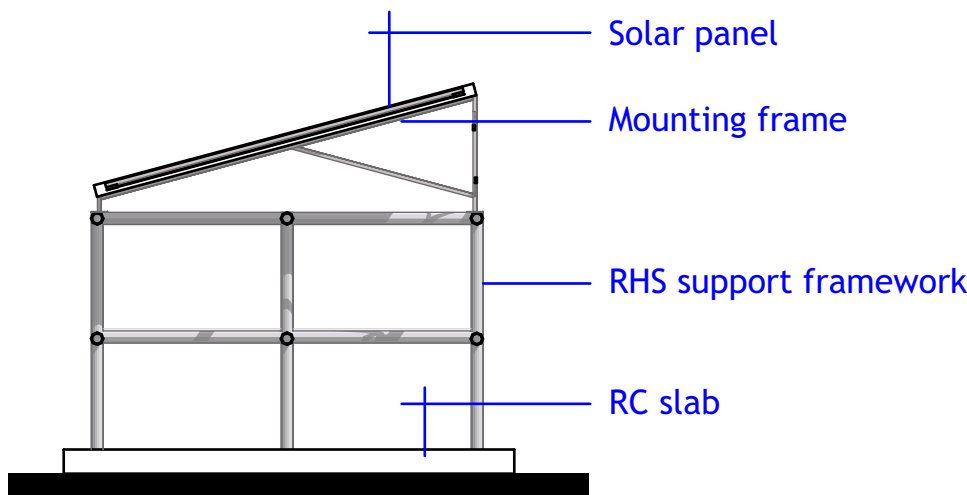


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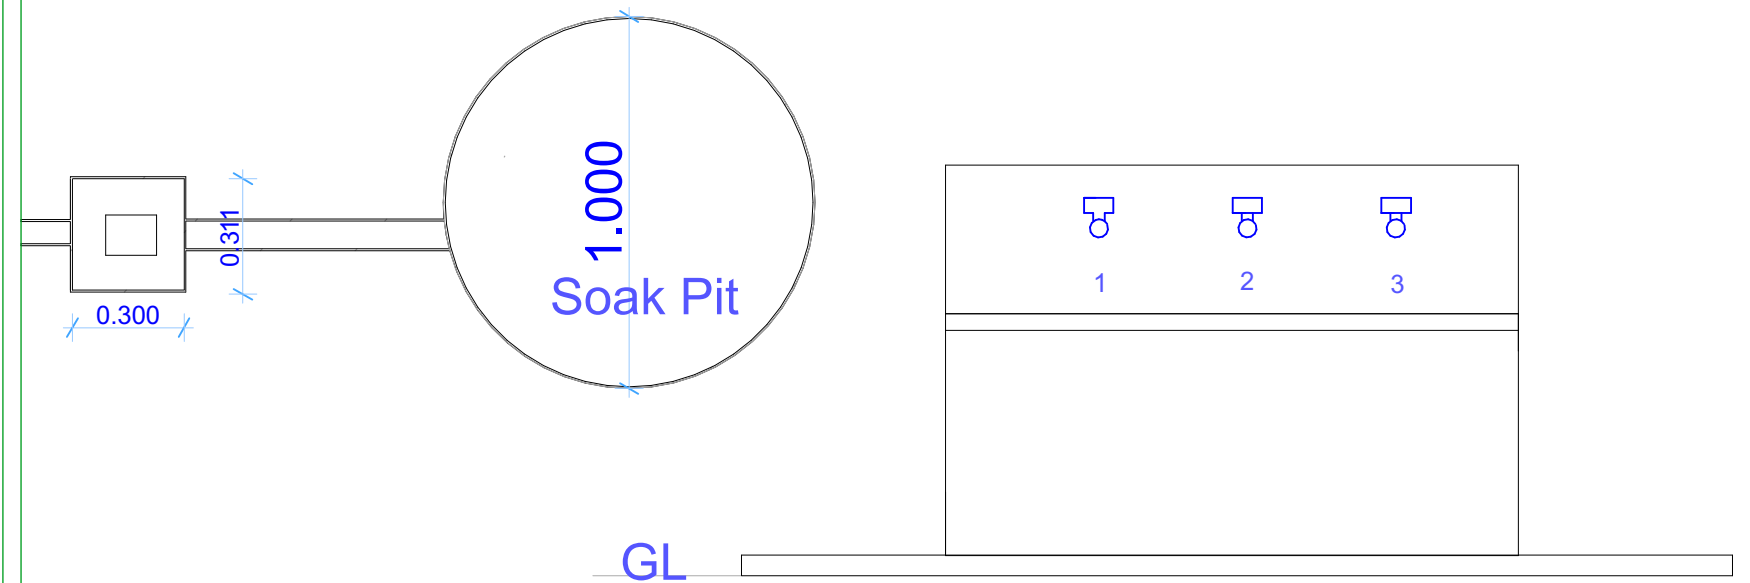
Section S-01

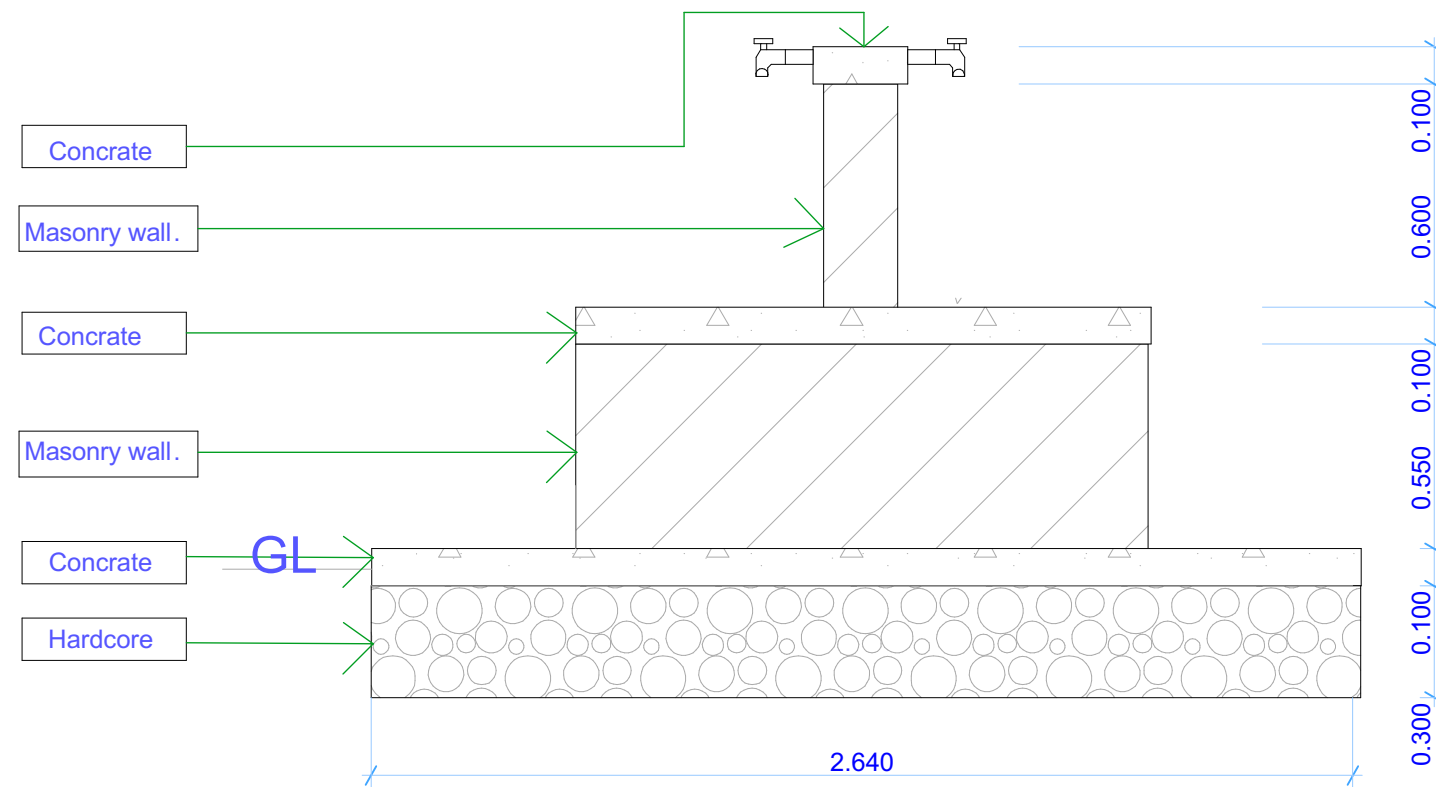

Side Elevation

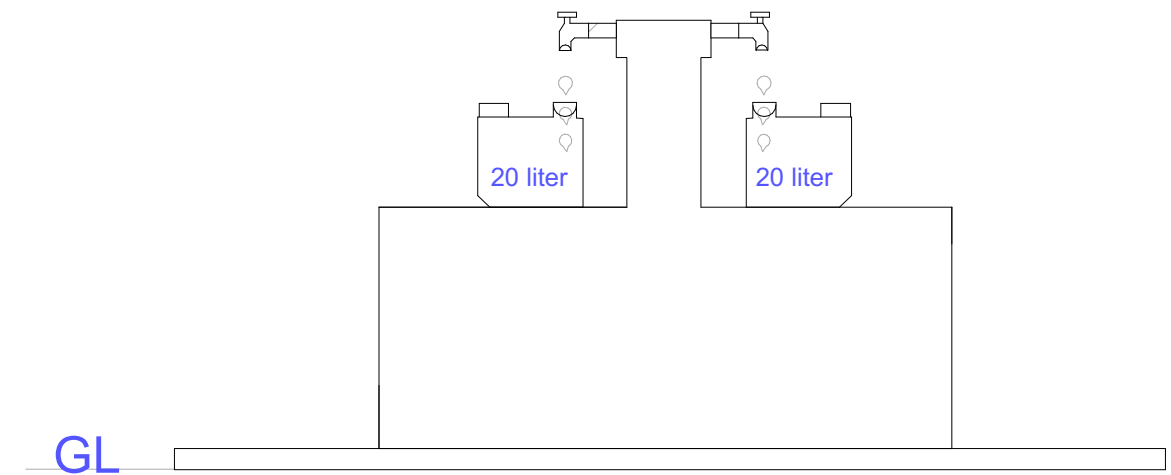

Floor Plan

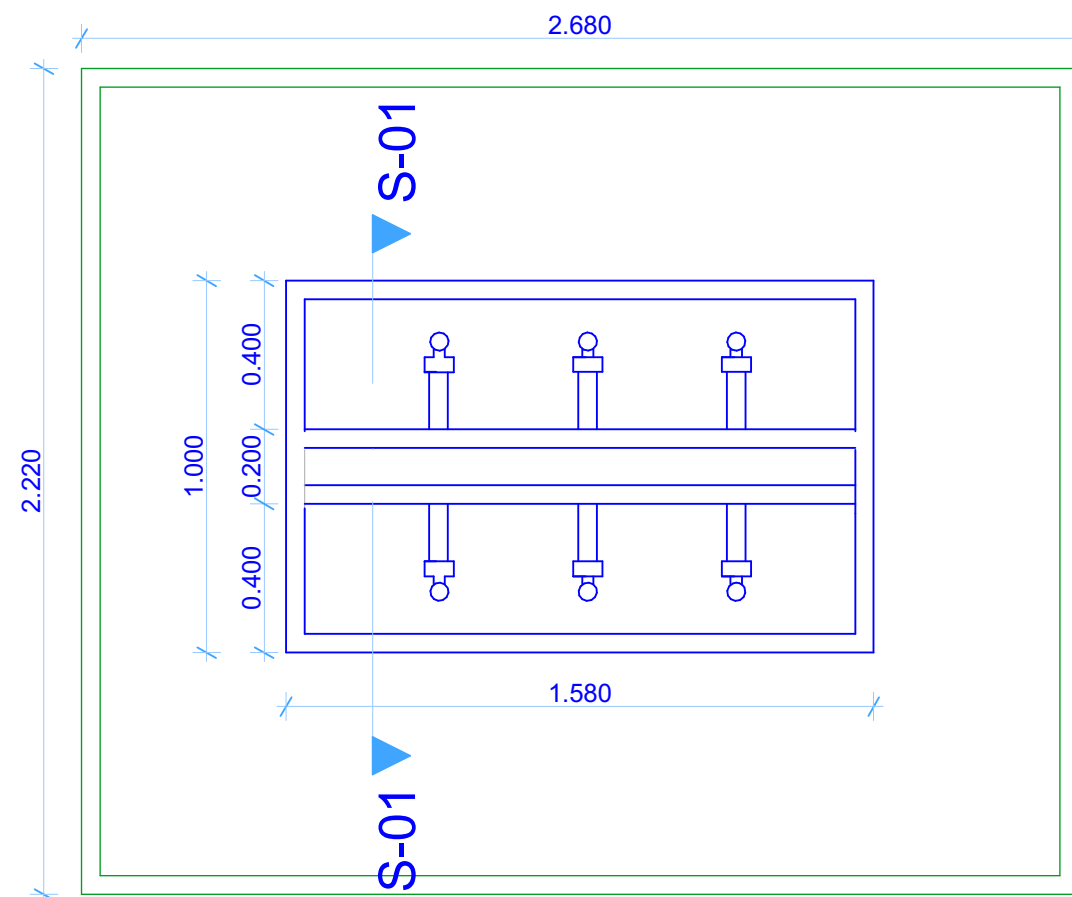

Front Elevation

GENERAL NOTES

1. All dimensions are in mm unless stated.
2. All dimensions to be checked and confirmed on site before commencement of any work.
3. Any discrepancy to be reported to the engineer promptly before proceeding.

PROJECT

EXCAVATION OF SHALLOW WELLS

IMPLEMENTING AGENCY



DEPARTMENT

WATER SANITATION AND HYGIENE
WASH

SCALE	
DATE	JUNE 2020
DESIGNED BY:	ENG. Wanja.D
DRAWN BY :	ENG. Wanja.D
REVIEWED BY:	
APPROVED BY:	



DRAWING TITLE:

DRAWING N^o:

PROJECT N^o:

WATER KIOSK

SHEET N^o:

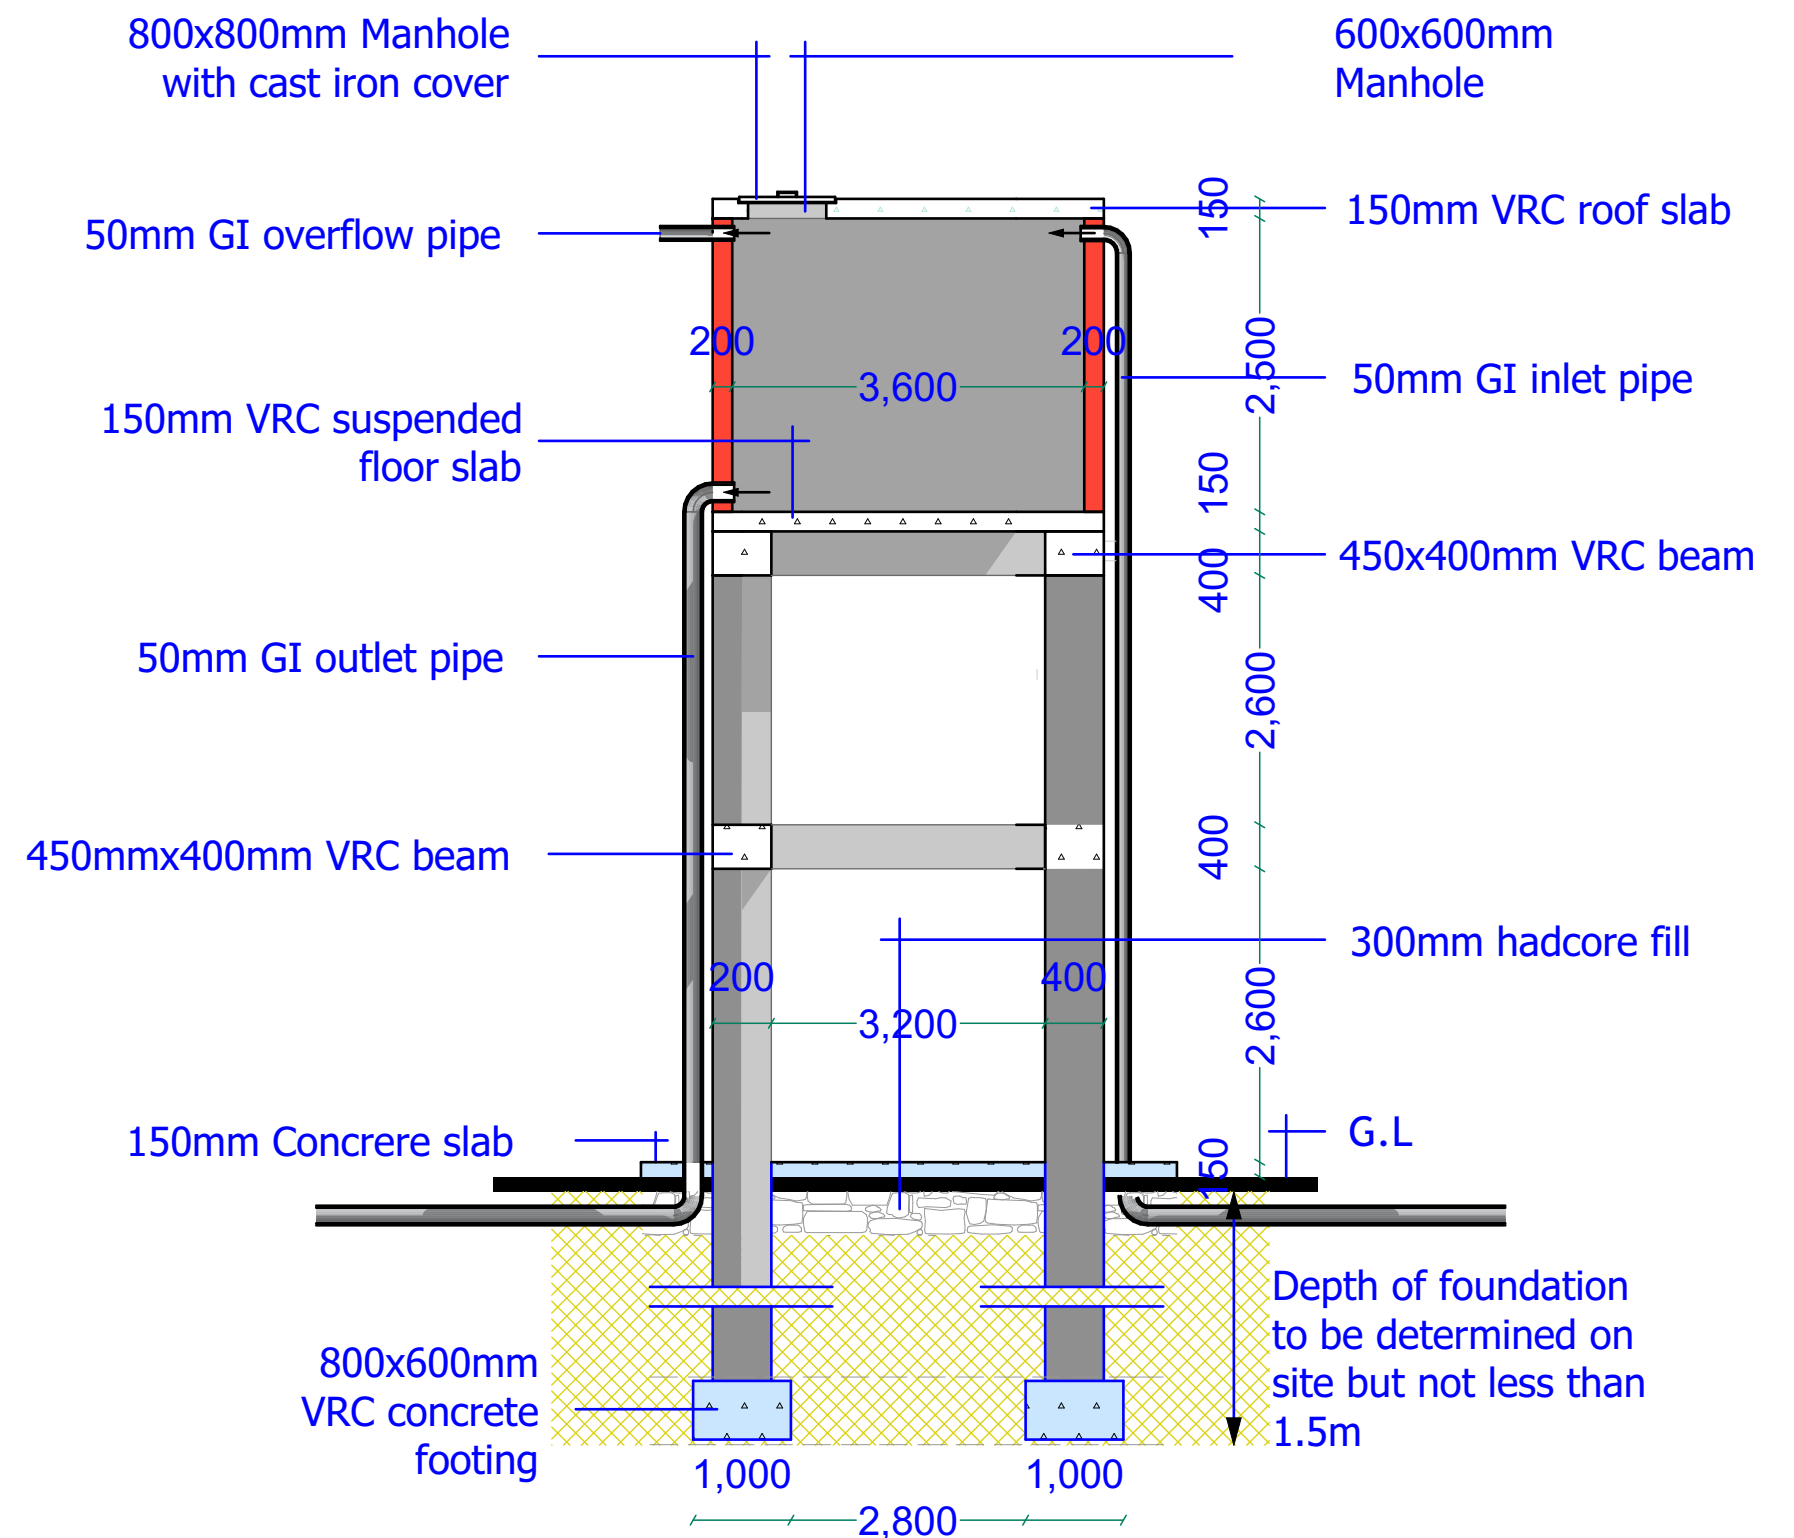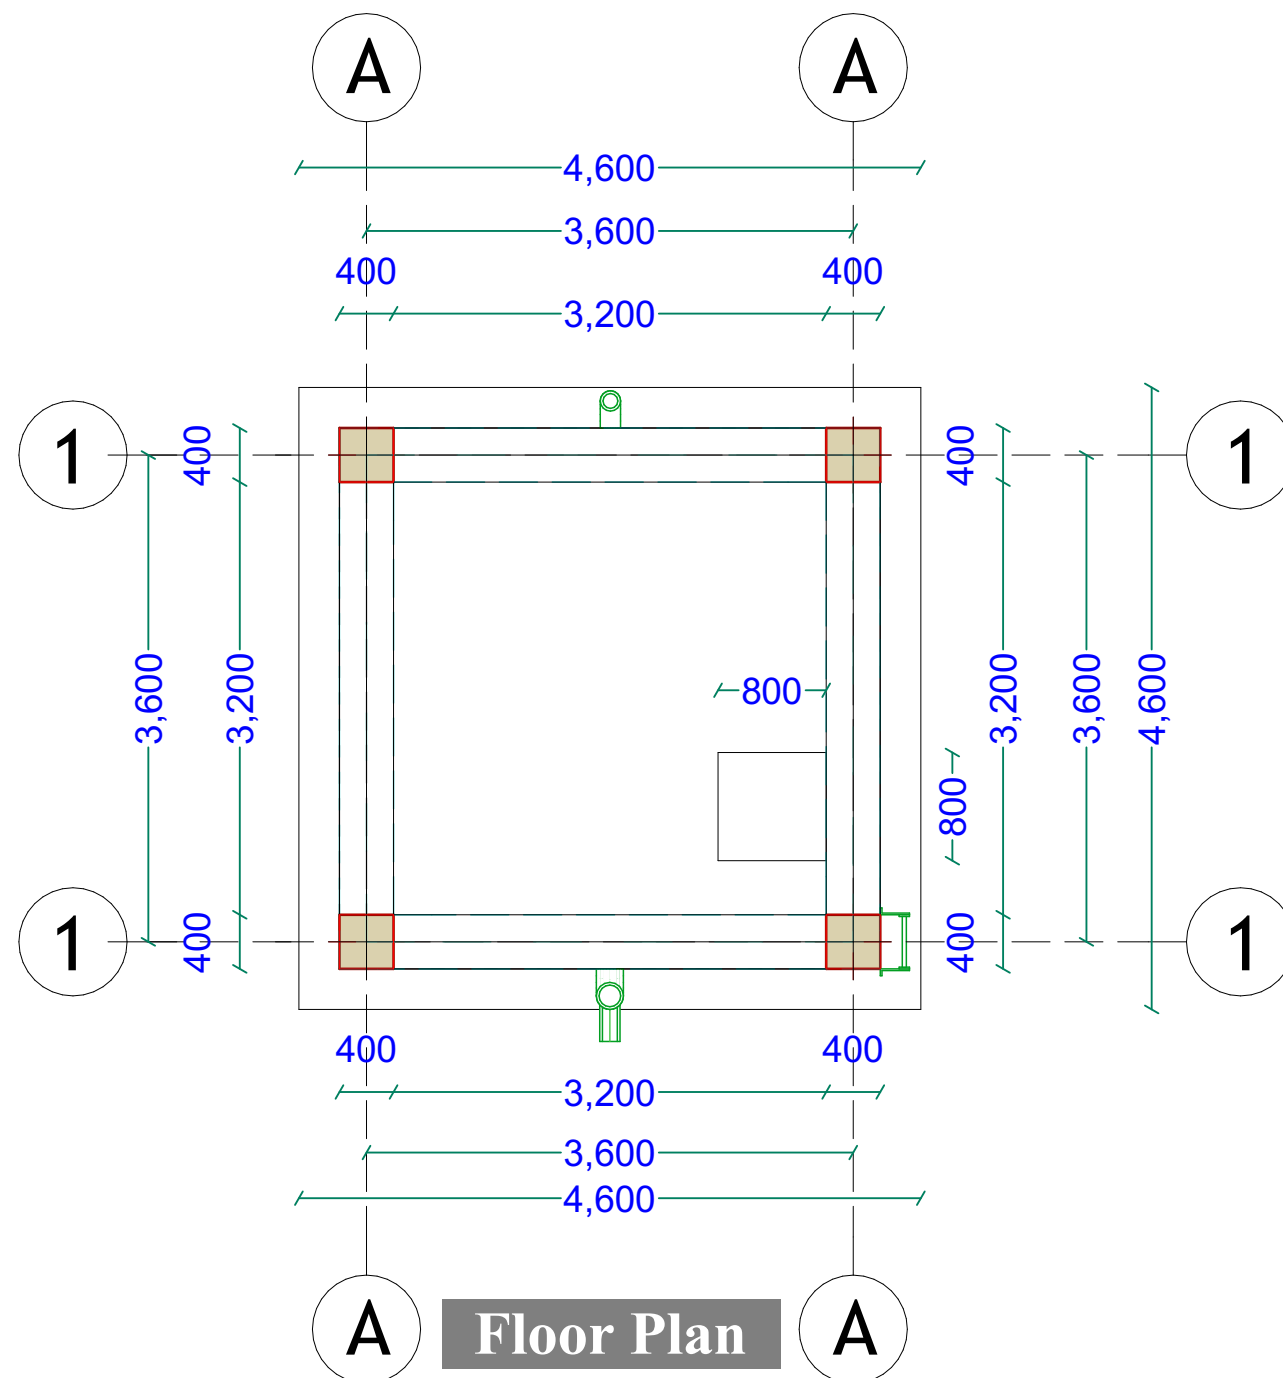

Sectional Elevation

GENERAL NOTES

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PROJECT

EXCAVATION OF SHALLOW WELLS

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DEPARTMENT

WATER SANITATION AND HYGIENE
WASH

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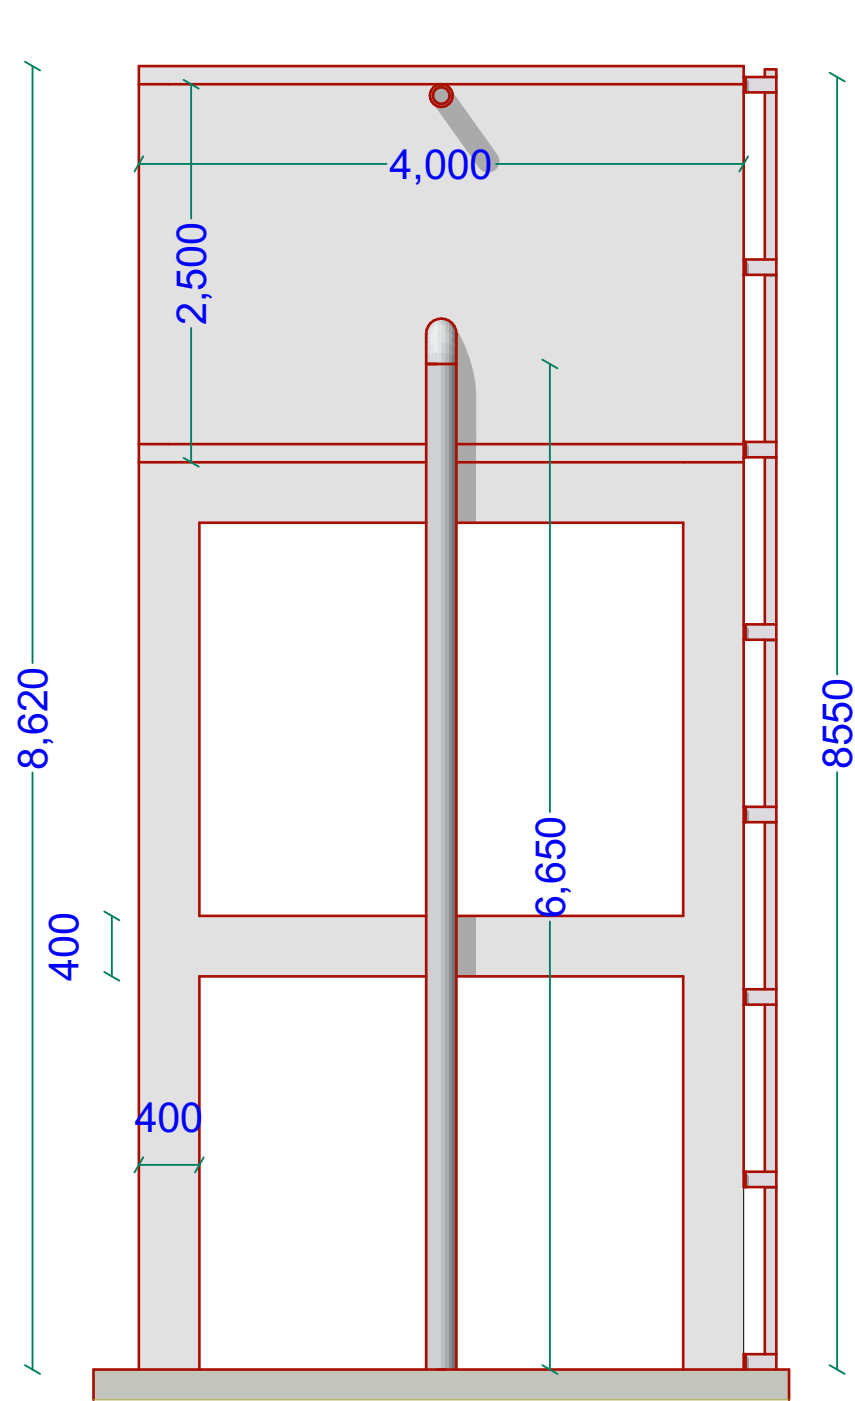
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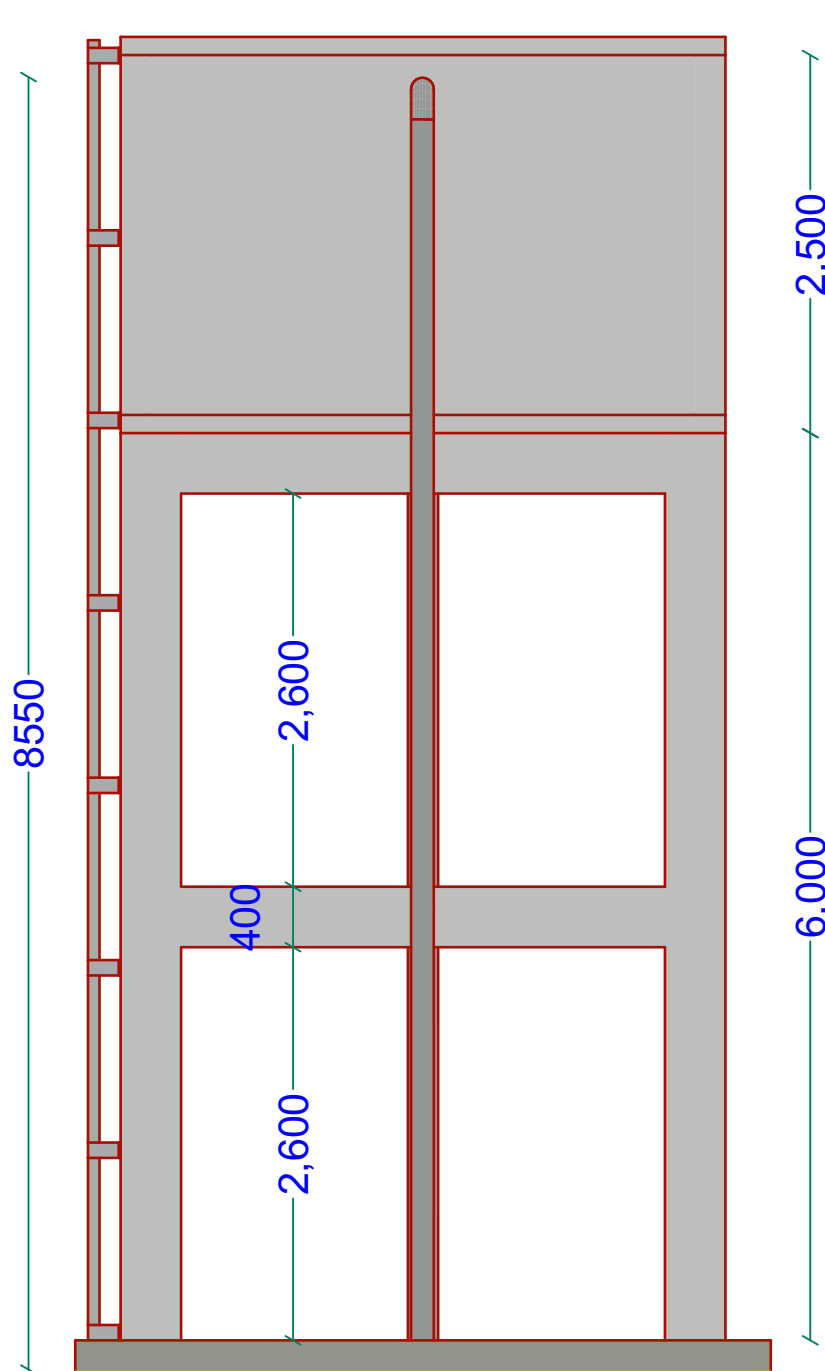
PROJECT N°:

ELEVATED TANK


SHEET N°:



South Elevation



North Elevation

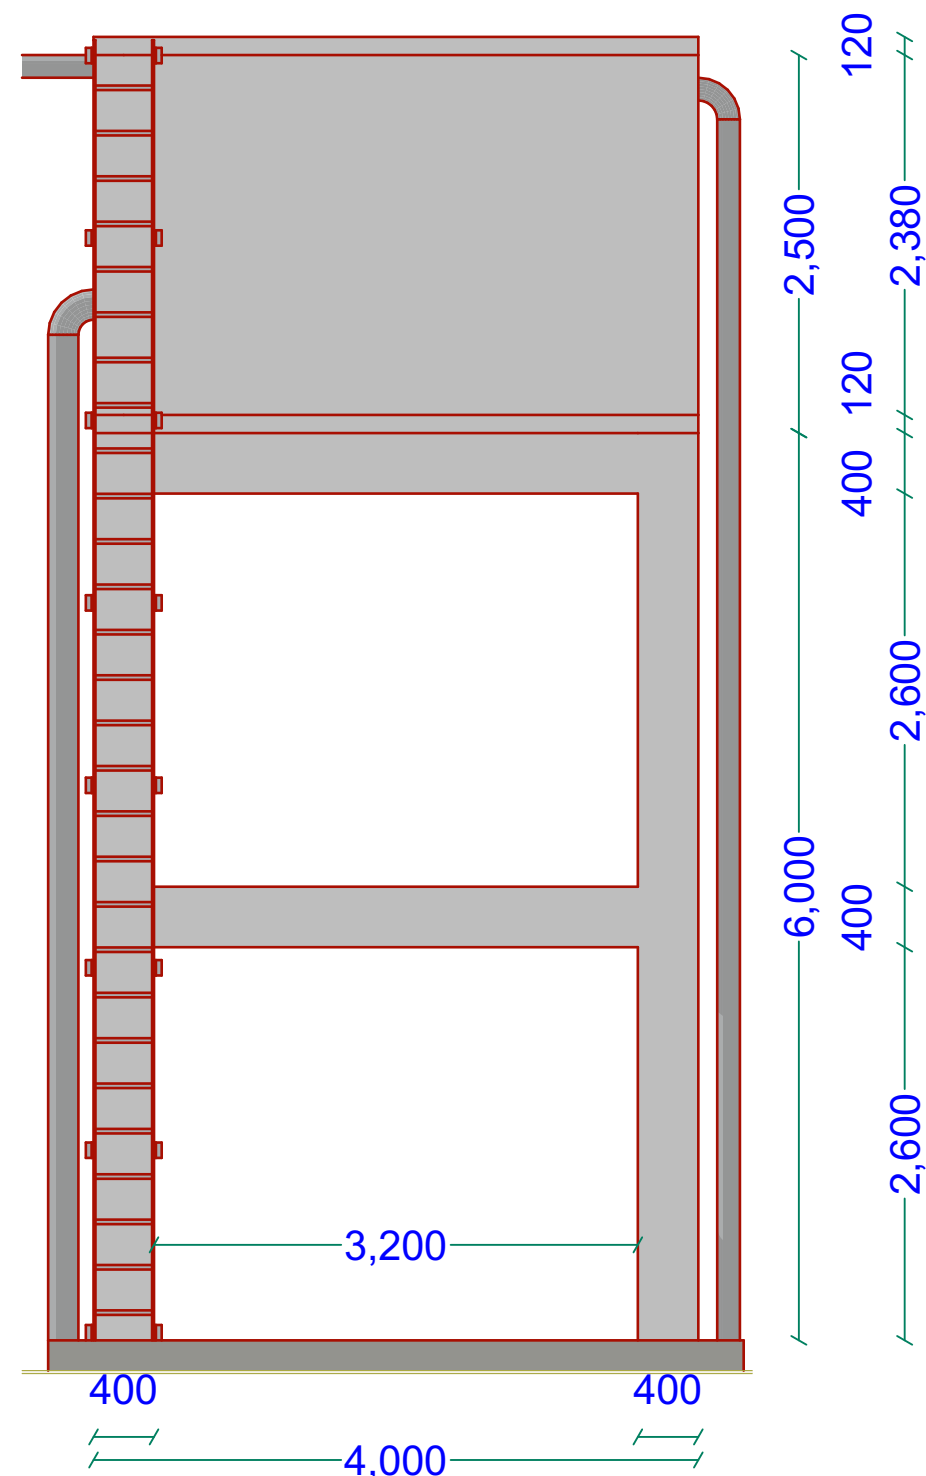

East Elevation

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PROJECT

EXCAVATION OF SHALLOW WELLS

IMPLEMENTING AGENCY



DEPARTMENT

WATER SANITATION AND HYGIENE
WASH

SCALE	
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DESIGNED BY:	ENG. Wanjia.D
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REVIEWED BY:	
APPROVED BY:	


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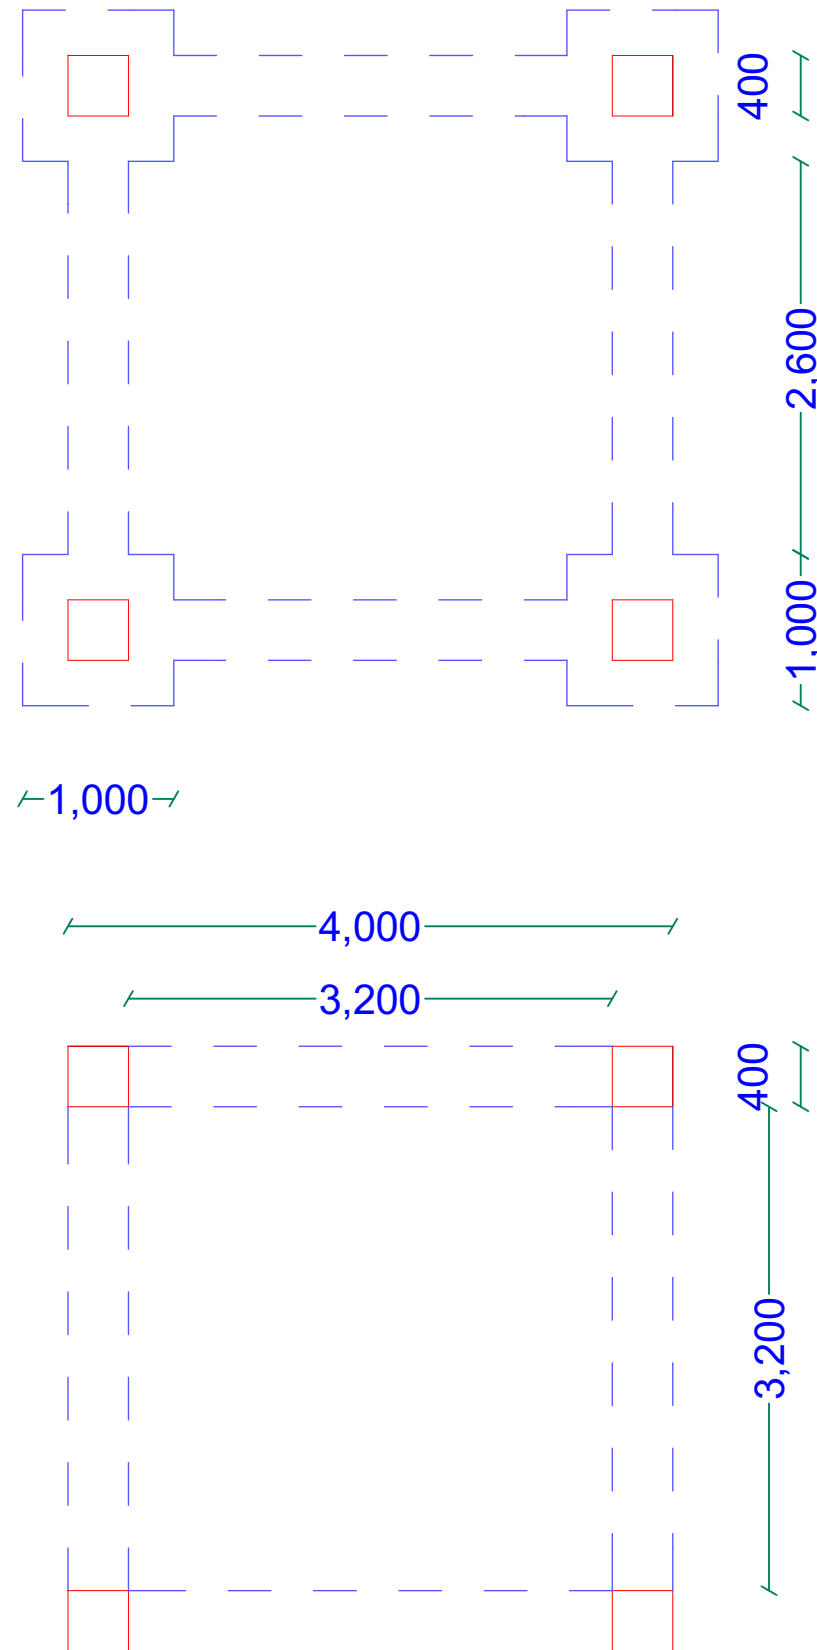
PROJECT N°:

ELEVATED TANK


SHEET N°:



West Elevation

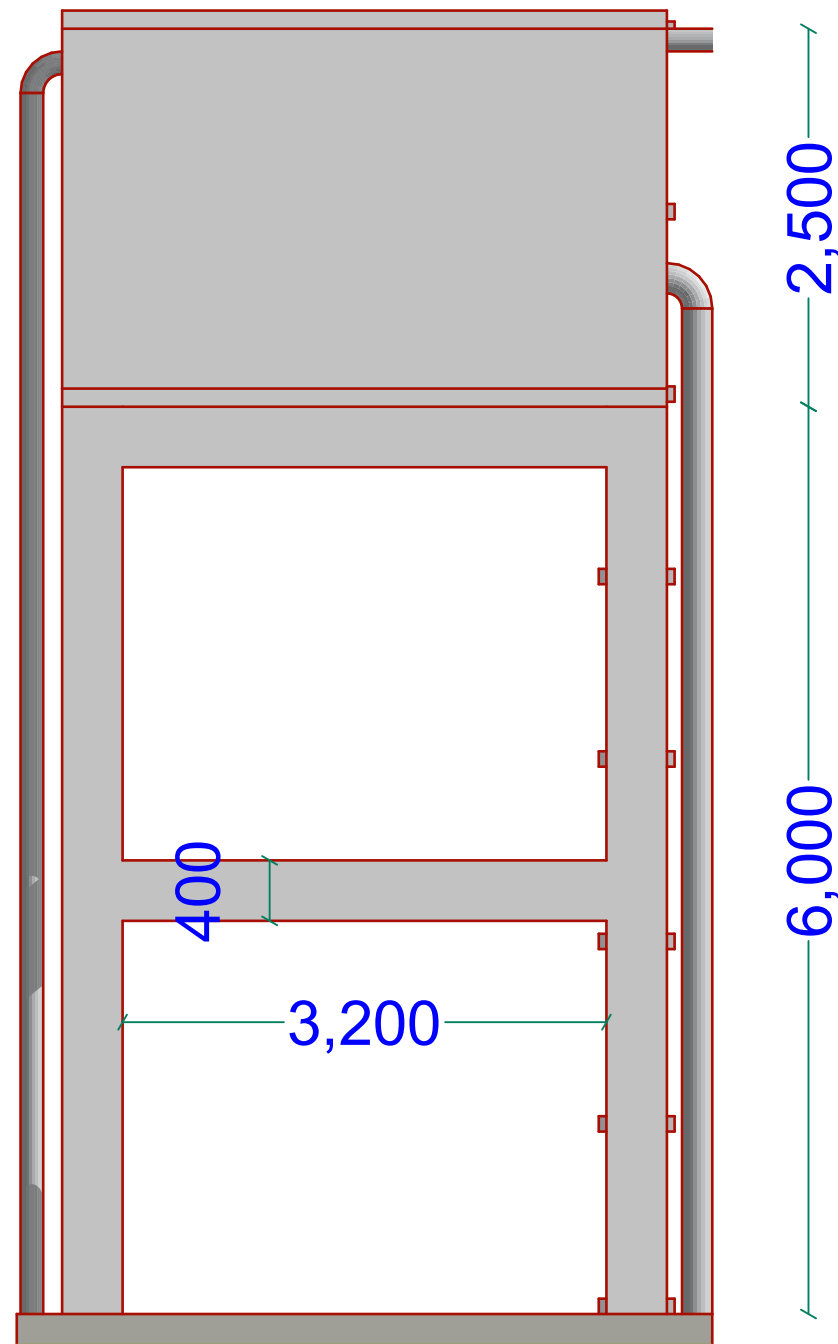


FOUNDATION LAYOUT

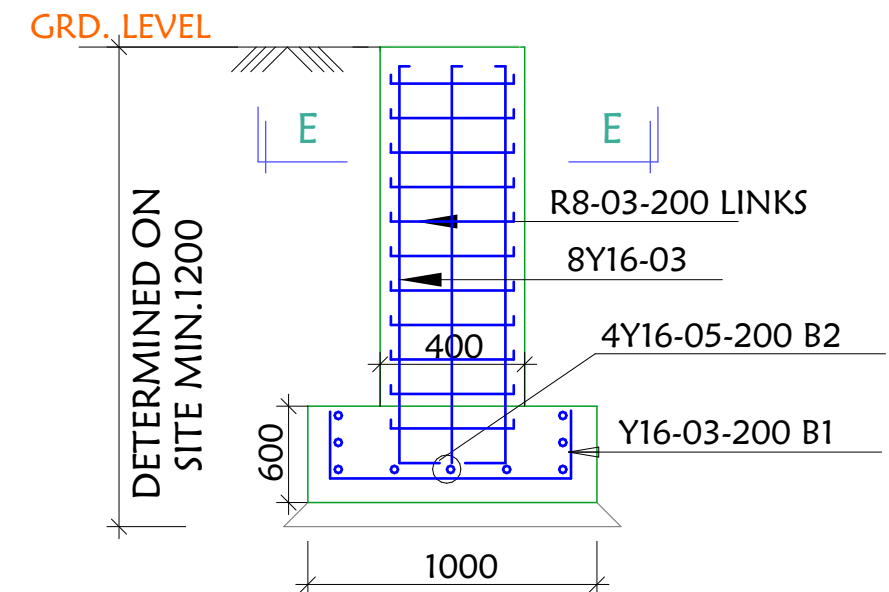

SECTION D-D

SCALE 1:25

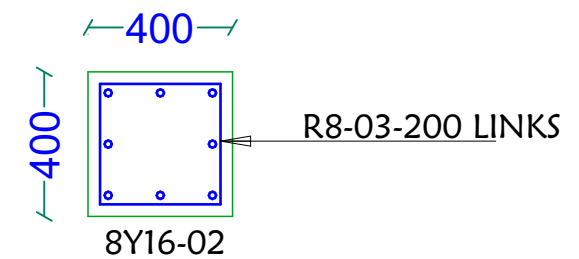

SECTION E-E (Column)

SCALE 1:25

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PROJECT

EXCAVATION OF SHALLOW WELLS

IMPLEMENTING AGENCY



DEPARTMENT

WATER SANITATION AND HYGIENE
WASH

SCALE	
DATE	JUNE 2020
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DRAWN BY:	ENG. Wanja.D
REVIEWED BY:	
APPROVED BY:	


DRAWING TITLE:

DRAWING N^o:

PROJECT N^o:

ELEVATED TANK

SHEET N^o:

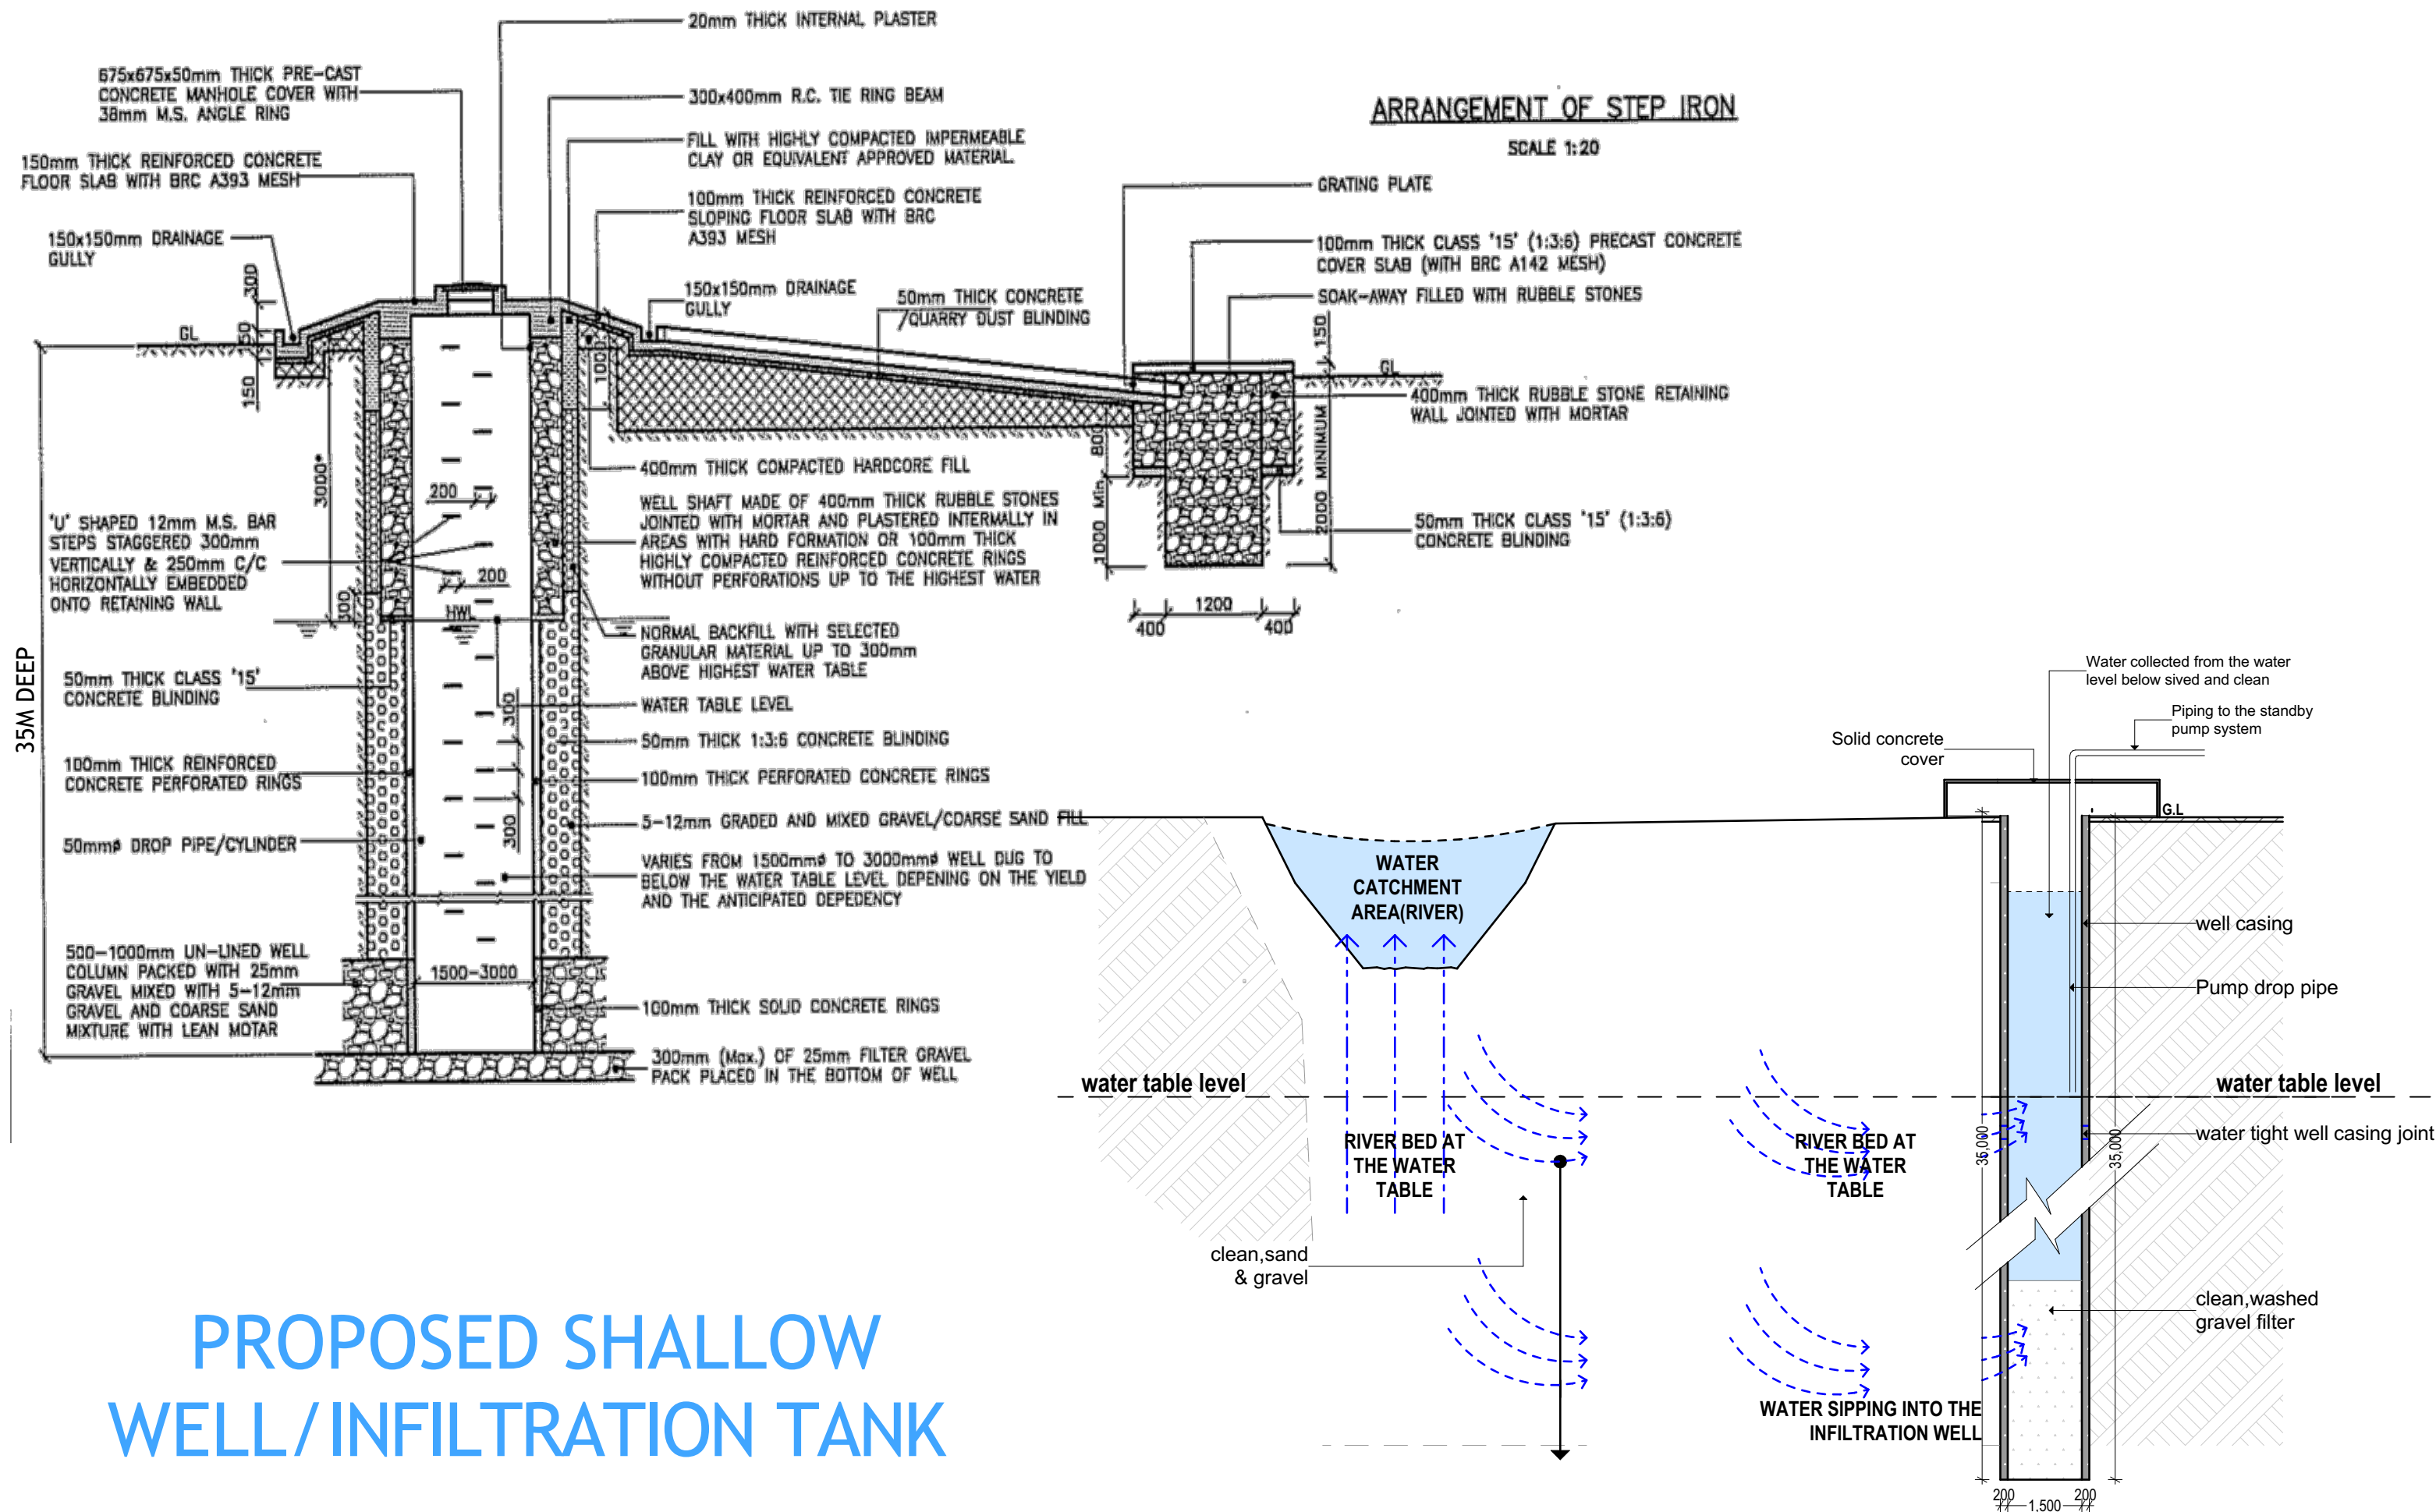

GENERAL NOTES

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PROJECT

EXCAVATION OF SHALLOW WELLS

IMPLEMENTING AGENCY



DEPARTMENT

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DATE	JUNE 2020
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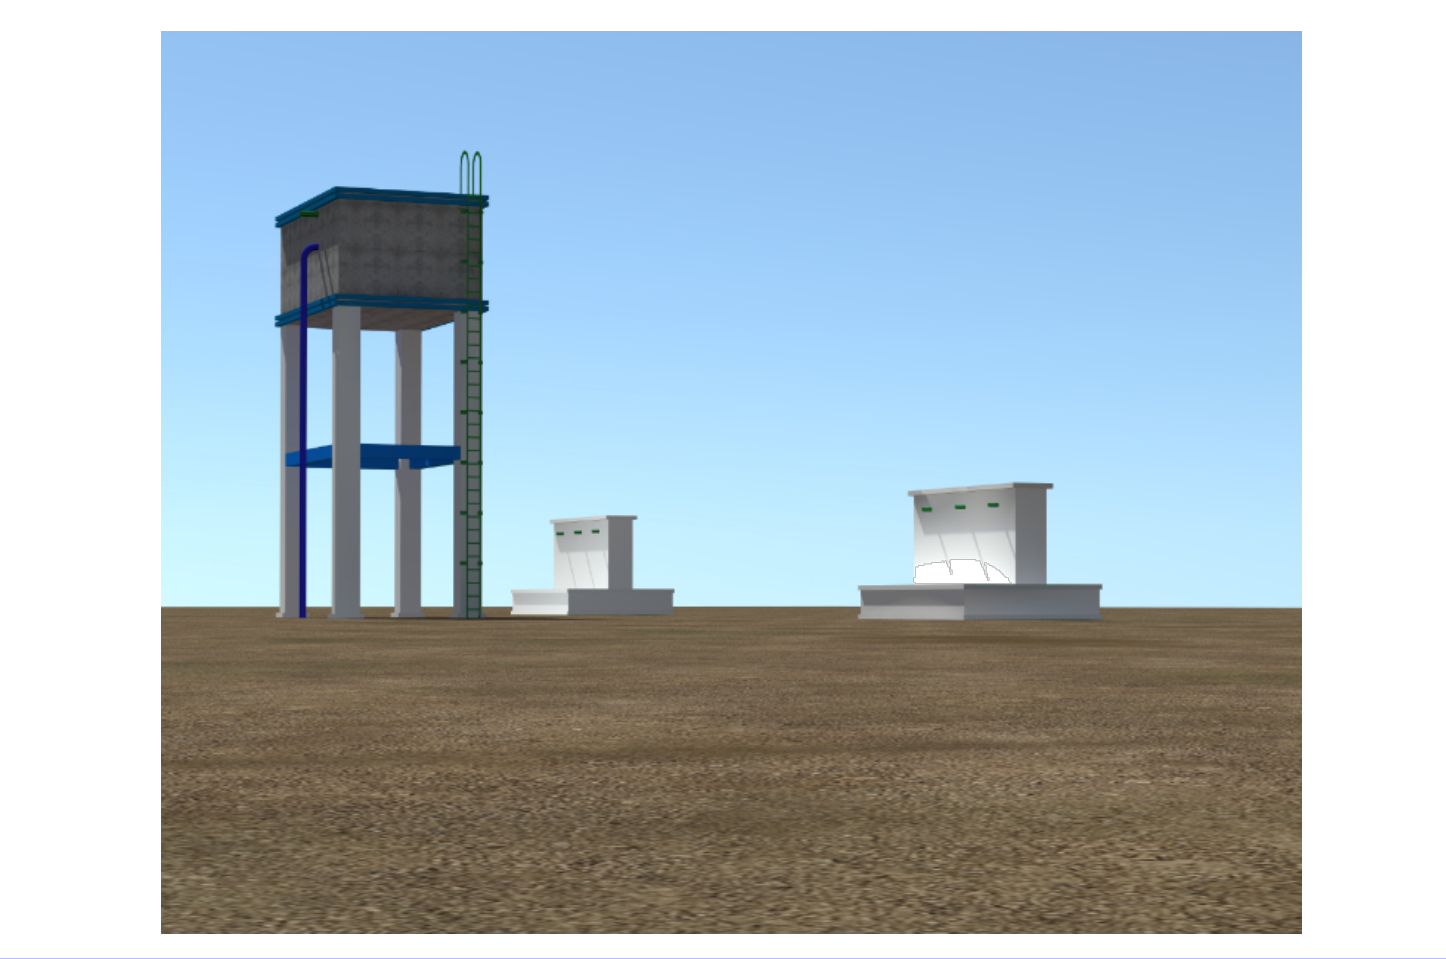
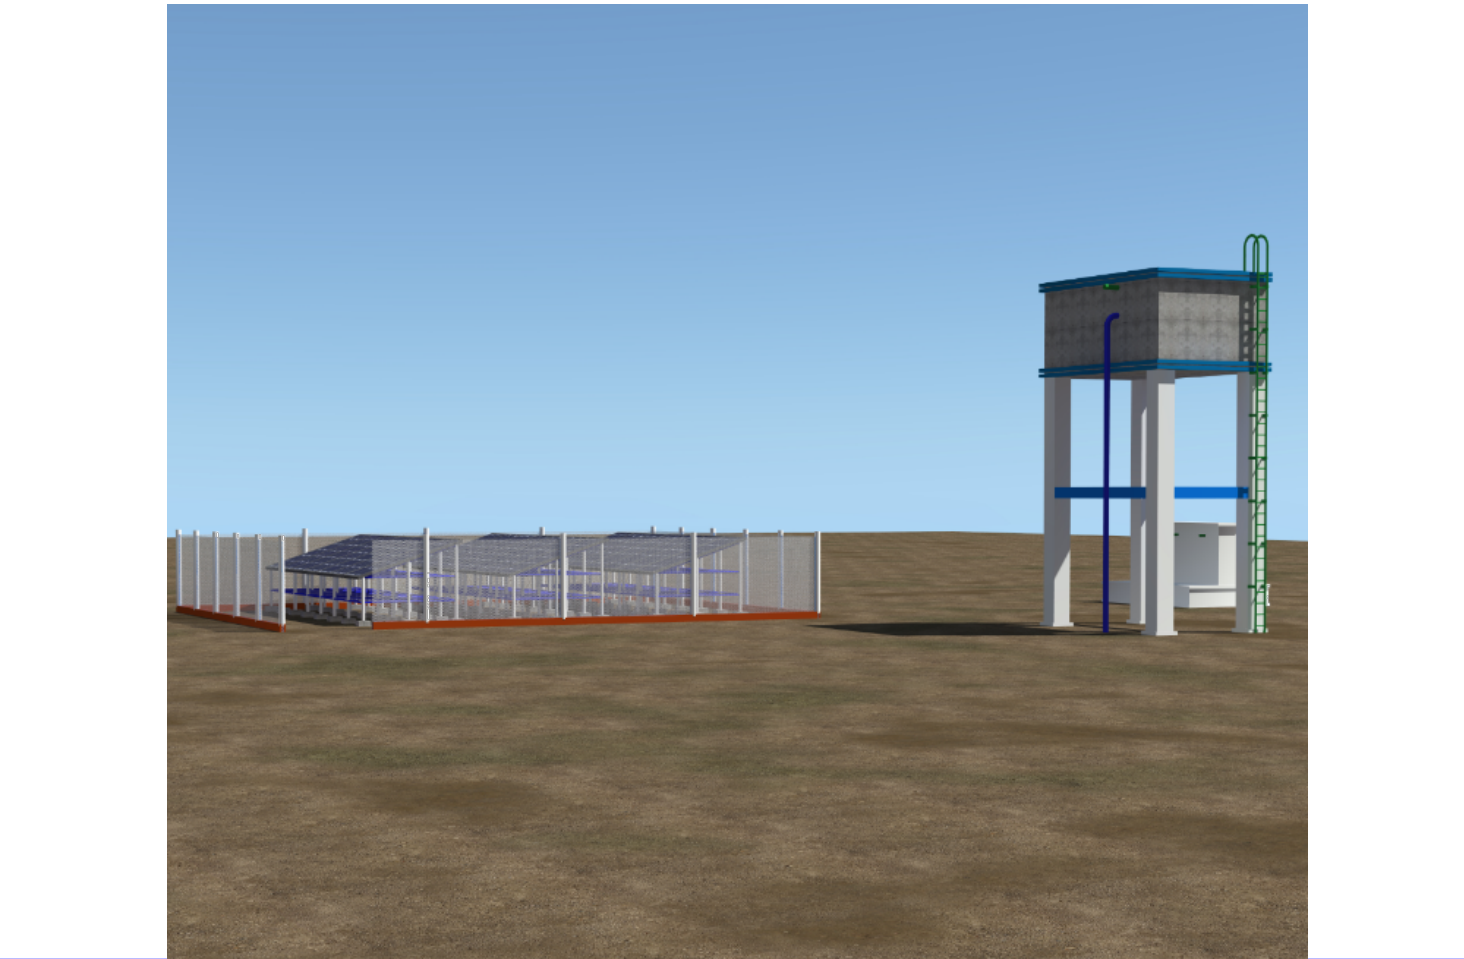
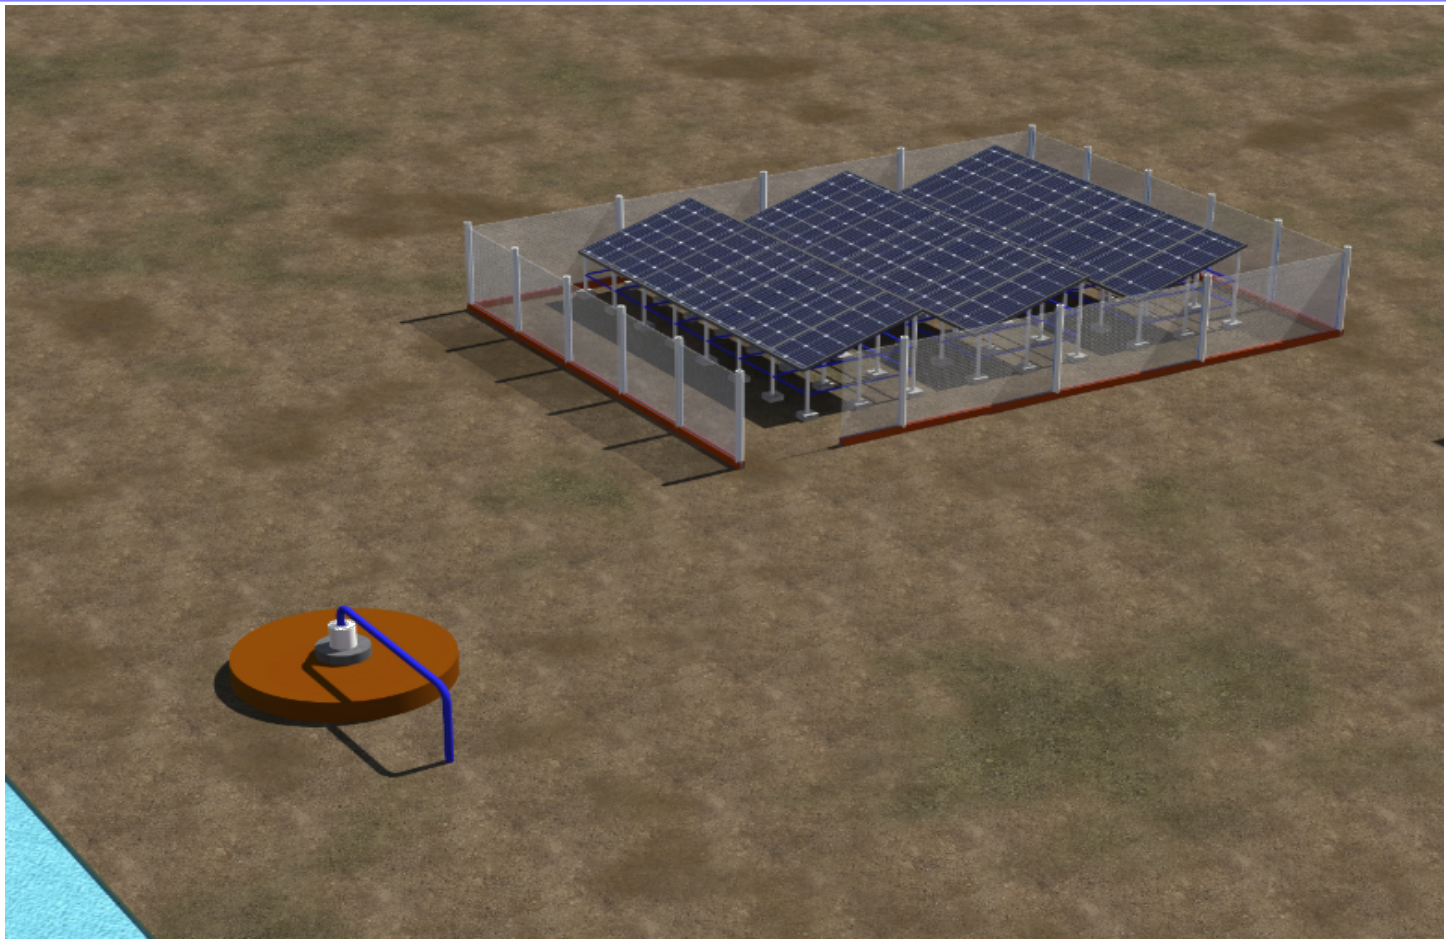
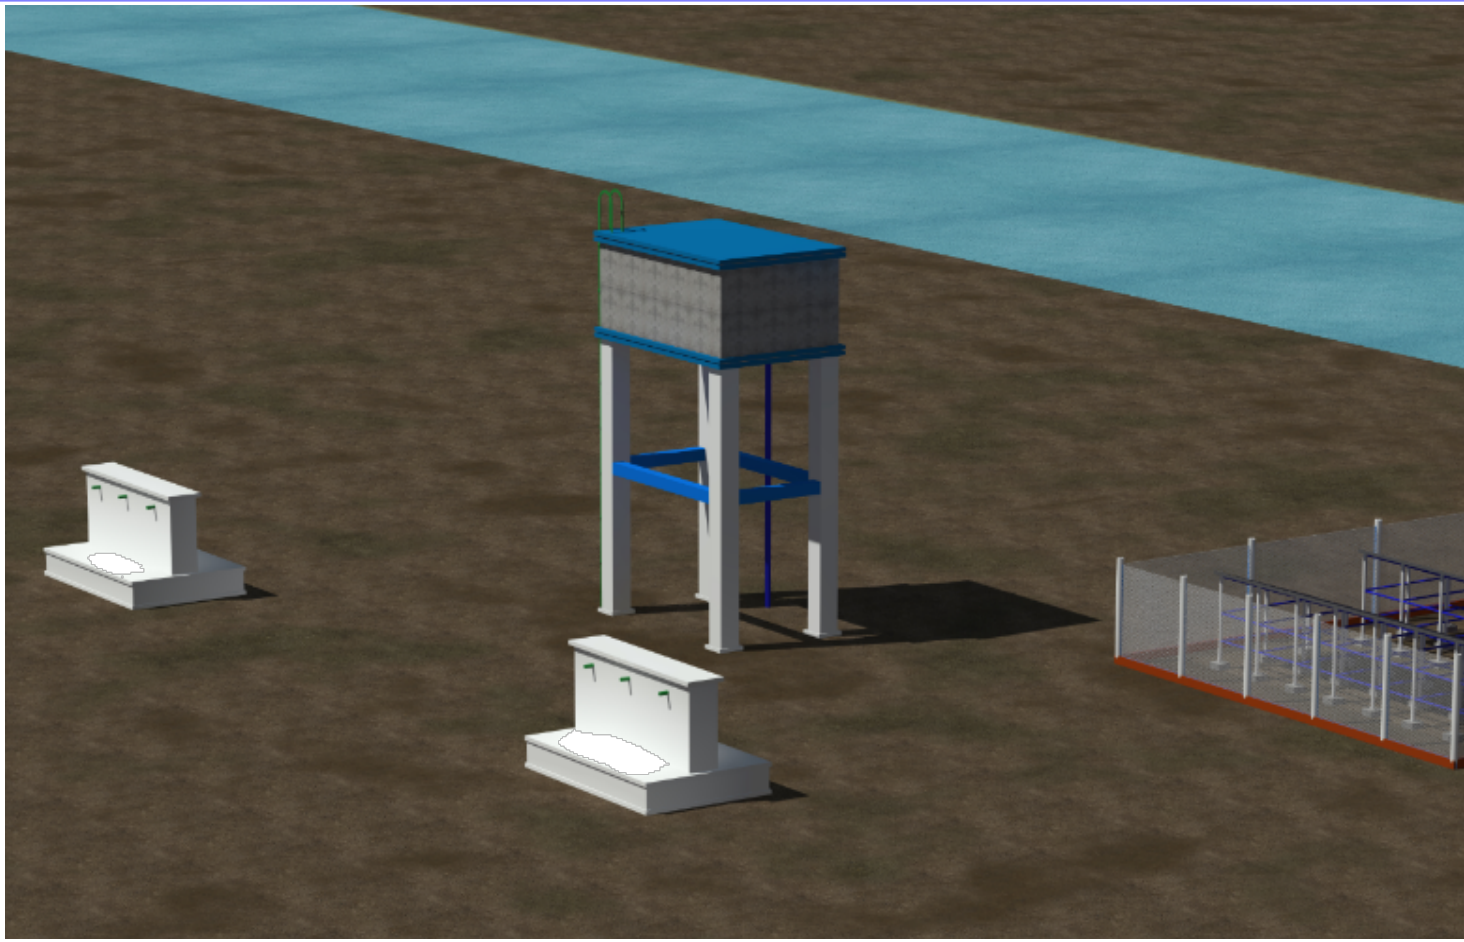
DRAWING TITLE:

DRAWING N^o:

PROJECT N^o:

SHALLOW WELL

SHEET N^o:



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PROJECT

EXCAVATION OF SHALLOW WELLS



DEPARTMENT

WATER SANITATION AND HYGIENE
WASH

SCALE		DRAWING TITLE:
DATE	JUNE 2020	
DESIGNED BY:	ENG. Wanja.D	DRAWING N ^o :
DRAWN BY :	ENG. Wanja.D	PROJECT N ^o :
REVIEWED BY:		
APPROVED BY:		

VIEWS
SHEET N ^o :

PS2-1800 C-SJ8-7

Solar Submersible Pump System for 4" wells

System Overview

Head	max. 40 m
Flow rate	max. 13 m³/h

Technical Data

Controller PS2-1800

Controlling and monitoring
Control inputs for dry running protection, remote control etc.
Protected against reverse polarity, overload and overtemperature
Integrated MPPT (Maximum Power Point Tracking)
Battery operation: Integrated low voltage disconnect
Integrated Sun Sensor

Power	max. 1,8 kW
Input voltage	max. 200 V
Optimum Vmp**	> 102 V
Motor current	max. 14 A
Efficiency	max. 98 %
Ambient temp.	-40...50 °C
Enclosure class	IP68

Motor ECDRIVE 1200-C / ECDRIVE 1800-C

Maintenance-free brushless DC motor
Water filled
Premium materials, stainless steel: AISI 304/316
No electronics in the motor

Rated power	1,7 kW
Efficiency	max. 92 %
Motor speed	900...3 300 rpm
Insulation class	F
Enclosure class	IP68
Submersion	max. 150 m

Pump End PE C-SJ8-7

Non-return valve
Premium materials, stainless steel: AISI 304
Optional: dry running protection
Centrifugal pump



Pump Unit PU1800 C-SJ8-7 (Motor, Pump End)

Borehole diameter	min. 4,0 in
Water temperature	max. 50 °C

Standards



2006/42/EC, 2004/108/EC, 2006/95/EC

IEC/EN 61702:1995

The logos shown reflect the approvals that have been granted for this product family. Products are ordered and supplied with the approvals specific to the market requirements.

**Vmp: MPP-voltage under Standard Test Conditions (STC): 1000 W/m² solar irradiance, 25 °C cell temperature




PS2-1800 C-SJ8-7

Solar Submersible Pump System for 4" wells

Pump Chart


$V_{mp^*} > 102 \text{ V}$

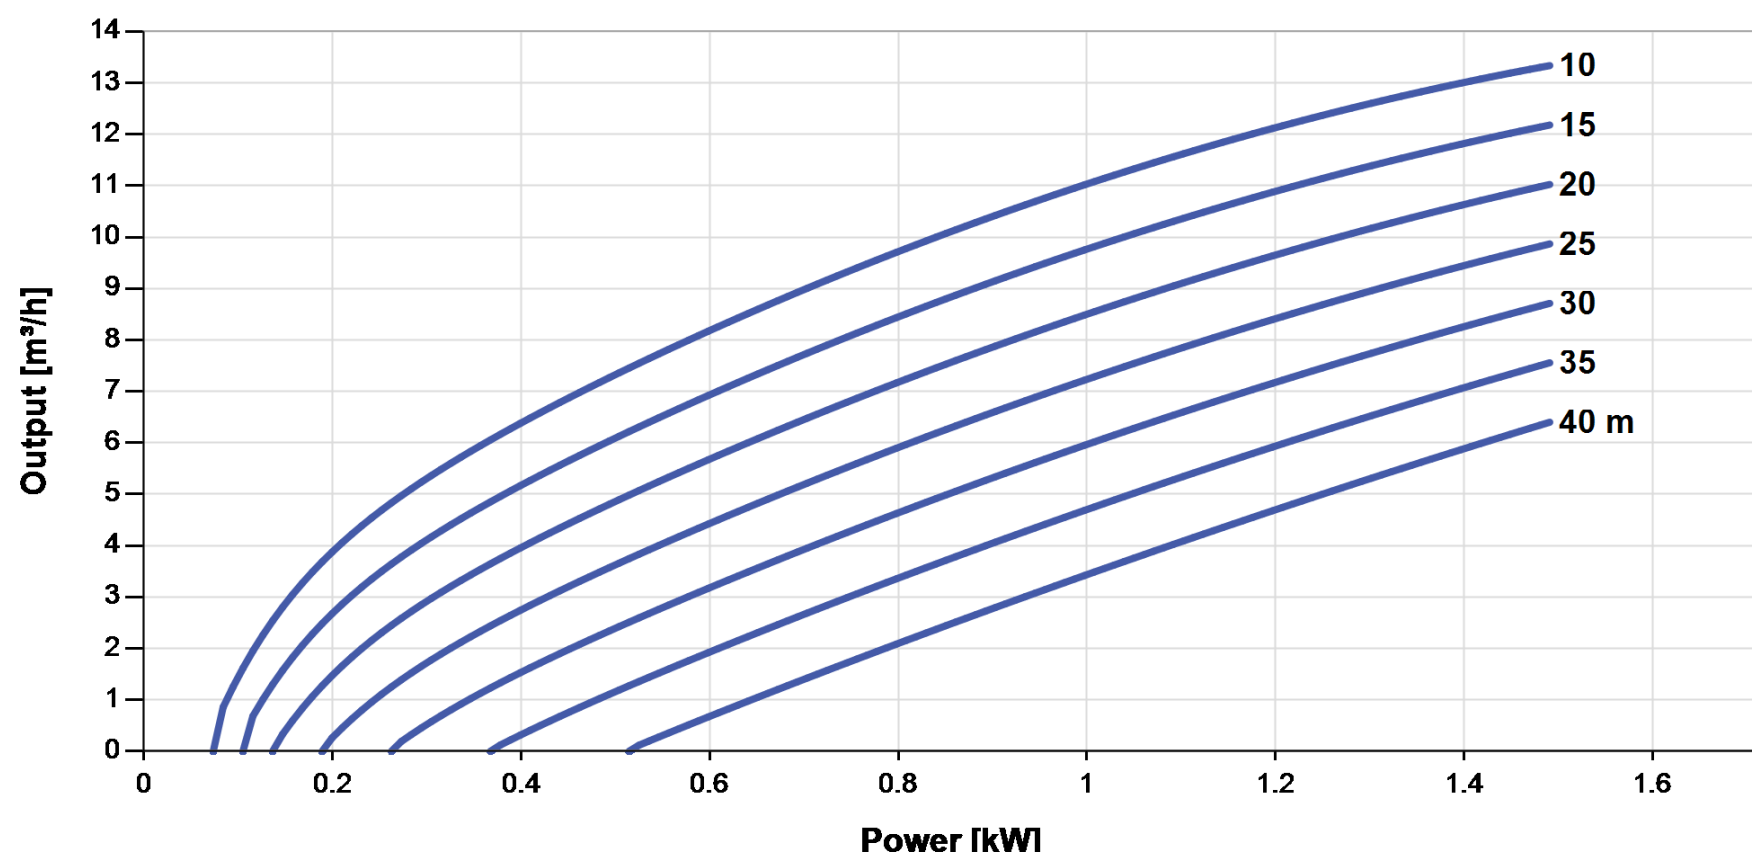

Dimensions and Weights


Controller

H1 = 352 mm
H2 = 333 mm
W1 = 207 mm
W2 = 170 mm
W3 = 164 mm
D1 = 124 mm

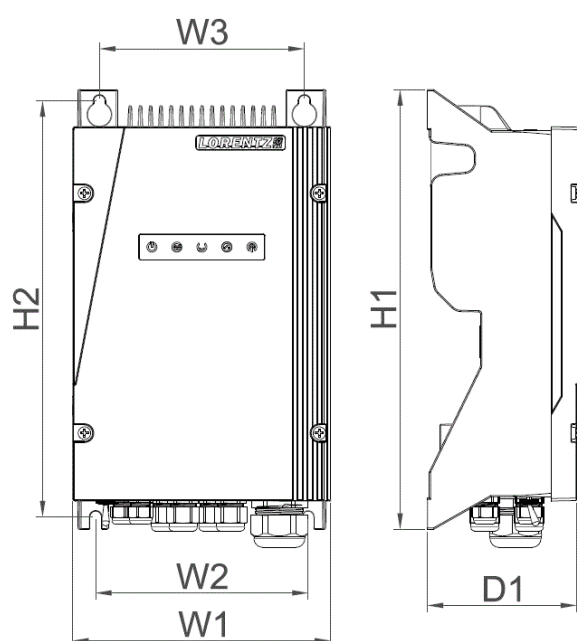

Pump Unit

A = 684 mm
B = 185 mm
C = 499 mm
D = 96 mm
E = 98 mm
S = 2 in

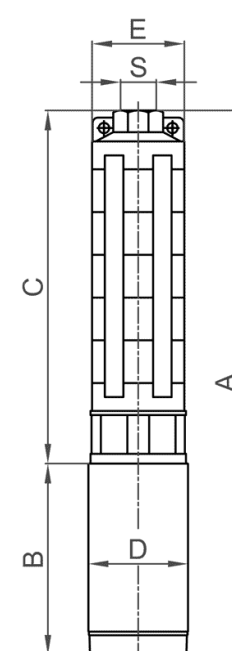

	Net weight
Controller	6,0 kg
Pump Unit	14 kg
Motor	7,0 kg
Pump End	6,5 kg

* V_{mp} : MPP-voltage under Standard Test Conditions (STC): 1000 W/m² solar irradiance, 25 °C cell temperature

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Germany, Tel +49 (0)4193 8806-700, www.lorentz.de



Created by LORENTZ COMPASS 3.1.0.95

All specifications and information are given with good intent, errors are possible and products may be subject to change without notice. Pictures may differ from actual products depending on local market requirements and regulations.

Sun. Water. Life.